

STAMP OF APPROVAL

SHEET NO. 1/3

Document certified by BHUSHAN RAMCHANDRA CHAUDHAE <brchaudhari@gmail.com</pre> Name : BHUSHAM RAMCHANDRA

20 Oct 2022

APPROVED SUBJECT TO THE CONDITION

MENTIONED IN This Office Letter CIDCO/BP-18209/TPO(NM & K)/2022/9988

Sr.	No	Particular	Area (sq.m)
		Area of plot (Minimum area of a, b, c to be considered)	
	a	As per ownership document (7/12, CTS extract)	650.000
1		as per measurement sheet	
	b	<u>'</u>	650.000
	С	as per site	650.000
		Deductions for	
2	_	Proposed D.P./ D.P. Road widening Area/Service Road / Highway	0.000
2	a b	Any D.P. Reservation area	0.00
	Ь	(Total a+b)	0.000
3		Balance area of plot (1-2)	650.00
		Amenity Space (if applicable)	0.00
	а	Required -	0.00
4	b	Adjustment of 2(b), if any -	0.00
	С	Balance Proposed -	0.00
5		Net Plot Area (3-4 (c))	650.00
_		Recreational Open space (if applicable)	0.00
6	a b	Required -	0.00
7	D	Proposed - Internal Road area	0.00
8		Plotable area (if applicable)	0.00
-		Built up area with reference to Basic F.S.I. as per front road width (Sr.	0.00
9		No. 5xbasic FSI) - 1.5 As per agrreement to lease	975.00
		Addition of FSI on payment of premium	
		Maximum permissible premium FSI - based on road width / TOD Zone.	
10		(plot area *0.3 premium FSI)	
10		Plus Additional FSI as per Note 3 of 10.10.1 (plot area *0.1)	
	a		0.00
	b	Proposed FSI on payment	0.000
		In-situ FSI / TDR loading	
	a	In-situ area against D.P. road [2.0 x Sr. No. 2 (a)],if any In-situ area against Amenity Space if handed over	
11	b	[2.00 or1.85 x Sr. No. 4 (b)and /or(c)],	
	С	TDR area-	
	d	Total in-situ / TDR loading proposed (11 (a)+(b)+(c))	0.00
12		Additional FSI area under Chapter No. 7	0.00
		Total entitlement of FSI in the proposal	
	а	[9 + 10(b)+11(d)] or 12 whichever is applicable.	975.00
13		Permissible Ancillary Area FSI upto 60% or 80% on balance potential	
13	b	with payment of charges.	0.00
	<i>c</i>	Proposed Ancillary area FSI	0.00
	d	Total entitlement (a+b)	975.00
		Maximum utilization limit of F.S.I. (building potential) Permissible as	
14		per Road width {(as per Regulation No. 6.1 or 6.2 or 6.3 or 6.4 as	
		applicable) x 1.6 or 1.8}, read with Note 3 of 10.10.1 or As per Agreement	4.50
		Agreement	1.50
15		Total Built-up Area in proposal.(excluding area at Sr.No.17 b)	973.31
	а	Existing Built-up Area	0.00
	b	Proposed Built-up Area (as per 'P-line')	973.31
		Residential	883.02
		Commercial	90.29
	С	Total (a+b)	973.31
16		F.S.I. Consumed	0.99
		Area for Inclusive Housing, if any	
17	a	Required (20% of Sr.No.5)	0.00
	b	Proposed	0.00
		No. Of Units	
		Total Commercial Units	

ote: The proposed chajjas over openings for protection from sun and rain and architectural features for decoration asthetic purpose shall not be used for any habitable purpose Certified that the plot under reference was surveyed by me on dt-_____ and the dimensions of sides etc. of plot

ated on plan are measured on site and the area so worked out tallies with the area stated in document of Ownership / T. P. Scheme Records / Land Records Department/ City Survey records. **EDGE ARCHITECTS**

> Ar. Daksha L. Gami (Reg. No. CA/2013/59413)

> > signature

Owner's Declaration

I/We undersigned hereby confirm that I/ We would abide by plans approved by Authority / Collector.I/We would execute the structure as per approved plans also I/We would execute the work under supervision of proper technical person so as to ensure the quality and safety at the work site.

owner (s) name and

GROUND FLOOR, LINE DIAGRAM & AREA CALCULATION & AREA STATEMENT, PARKING STATEMENT, CARPET AREA STATEMENT, BUILT UP AREA CAL., BLOCK PLAN, GATE ELEVATION, P-LINE AREA CAL, GROUND FLOOR,

NOTE BOUNDRY WALL OF PLOT SHOWN BLACK. PROPOSED STRUCTURE SHOWN RED. DRAINAGE LINE SHOWN RED DOTTED LINE WATER LINE SHOWN BLUE DOTTED LINE. INTERNAL WALL (0.10) EXTERNAL WALL (0.15

RCHITECT'S NAME & SIGNATURE:

Total Residential Units


AR. DAKSHA.L. GAMI DWNER'S NAME & SIGNATURE

SHRI.JAYESH KRISHNA MHATRE, SHRI.KRISHNA VITTHAL MHATRE, SHRI MEGHANATH KRISHNA MHATRE, M/S.VASUNDHARA GROUP THROUGH IT'S PARTNERS SHRI.MITESH BHANII BERA ,SHRI.SUHIT SHANKAR BHANUSHALI.


FILE NO. - CIDCO/BP-18209/TPO(NM & K)/2022

PROPOSED RESIDENTIAL CUM. COMMERCIAL BUILDING ON PLOT-17 G, SEC-25A, PUSHPAK AR. DAKSHA .L.GAMI


CHECKED BY DRAWN BY KOMAL SCALE

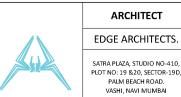


OFFICE: 022-27842277/ 228

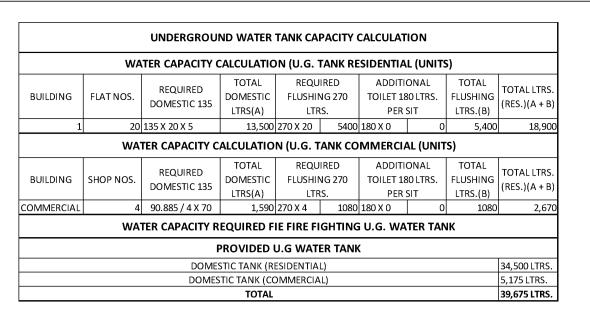


	OVERHEAD WATER TANK CAPACITY CALCULATION								
USE REQUIRED OVERHEAD WATER TANK PROVISION (LITRE)									
		TANK SIZE (METER	NUMBER OF TANK	CAPACITY (LITRE)					
1	2	3	4	5					
DOMESTIC	20,700	4.61 X 2.40 X 2.00	1	22,128 LTR					
COMMERCIAL	3,105	0.90 X 2.40 X 2.00	1	4,320 LTR					
TOTAL	23,805			26,448 LTR					
NOTE :-									
i	OVERHEAD TANK CAPACITY SHALL BE MINIMUM 60% OF WATER REQUIREMENT								
ii	SIZE OF OVERHEAD TANK IS EXCLUDING FREEBOARD								

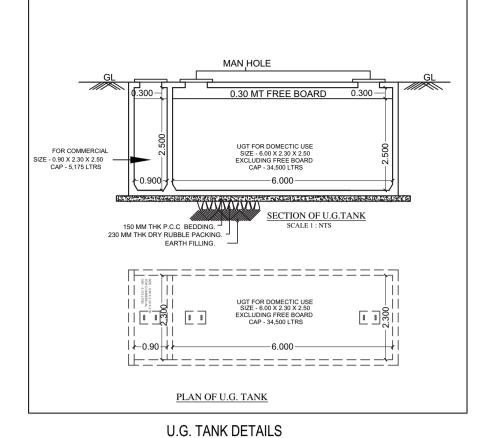

SCALE 1:100

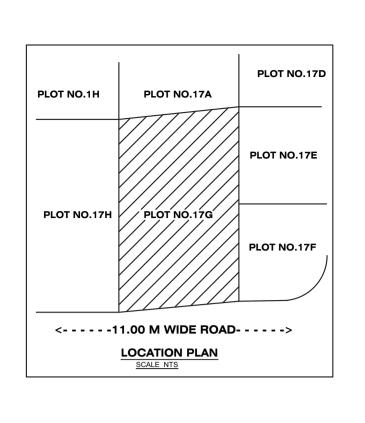

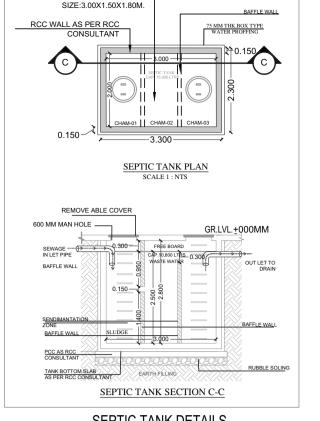

SEPTIC TANK CAP: 8,100 LTS. SIZE:3.00X1.50X1.80M. BAFFLE WALL	ROOM	AREA OF ROOM(SQ.M)	AREA OF 1/10 WIN REQUIRED SQ.M)	AREA OF PROVIDI
₹0.150	LIVING ROOM	11.475	1.147	5
(c)	BED ROOM	8.100	0.810	5
3.300 LIST -	KITCHEN	4.400	0.440	3
	WC	1.140	0.114	0
	BATH	1.500	0.150	0
0.150				
SEPTIC TANK PLAN SCALE 1 : NTS		SE	PTIC TANK STA	TEMENT
	SEPTIC TANK:			
REMOVE ABLE COVER 600 MM MAN HOLE CRIVI +000MM	NO OF FLATS			20
GR.LVL.±000MM				

SEPTIC TANK DETAILS	
SCALE 1:100	

SEPTIC T	ANK:					
NO OF F	LATS	20				
20 FLAT	S X 400 Ltrs.			8,0	00 Ltrs.PE	R FLATS
REQUIRI	EMENT			8,0	00 Ltrs.	
PROVID	ED :-			•		
2.00 X 3.	00 X 2.50			15,	000 Ltrs.	
Α	AREA OF BLOCK [ABCD]	YPICAL FLOC 11.430	X : 131 10	28.053	320.64465	SQ .MT
A	AREA OF BLOCK [ABCD]	11.430	Χ	28.053	320.64465	SQ .IVII
	STANDARD DI	EDUCTIONS			NOS	SQ .M
L1	2.100	Х	2.301	Х	1	4.832
1	5.270	Χ	1.050	Х	2	11.067
2	0.450	Χ	1.350	Х	2	1.215
3	1.750	Х	1.030	Х	2	3.605
4	2.400	Х	2.070	Х	2	9.936
_	4 700					

LIGHT & VENTILATION SCHEDULE

AREA OF WINDOW

PROVIDED (SQ.M)

5.04

5.04

3.36

0.54

0.54


WIN.

W1

W1

W2

Α	AREA OF BLOCK [ABCD]	11.430	Х	28.053	320.64465	SQ .MT	
	STANDARD DE	DUCTIONS			NOS	SQ .MT	
L1	2.100	Χ	2.301	Χ	1	4.832	
1	5.270	Χ	1.050	Χ	2	11.067	
2	0.450	Χ	1.350	Χ	2	1.215	
3	1.750	Χ	1.030	Χ	2	3.605	
4	2.400	Χ	2.070	Χ	2	9.936	
5	1.763	Χ	2.551	Χ	1	4.497	
6	1.344	Χ	3.080	Χ	1	4.140	
7	1.900	Χ	1.022	Χ	1	1.942	
8	0.250	Χ	3.000	Χ	1	0.750	
9	1.450	Χ	2.750	Χ	1	3.988	
10	0.750	Χ	2.670	Χ	2	4.005	
11	1.450	Х	2.350	Χ	1	3.408	
12	0.946	Χ	2.120	Χ	1	2.006	
13	1.750	Χ	0.900	Χ	2	3.150	
14	0.450	Χ	1.350	Χ	2	1.215	
15	2.400	Х	2.120	Х	1	5.088	
16	1.480	Χ	2.980	Χ	1	4.410	
17	0.280	Χ	3.000	Χ	1	0.840	
18	1.180	Χ	1.152	Χ	1	1.359	
19	0.750	Х	1.072	Х	1	0.804	
20	1.417	Х	5.500	Х	1	7.794	
	TOTA	AL DEDUCTION	ON			80.051	
	GROSS AREA = A - D		320.6446	-	80.051	240.594	
	NET BUILT-UP AREA					240.594	
	NET B.U.A. 1ST TO 3RD 240.594 X 3						
	TYPICAL FLOOR (1ST TO 3RD FLOOR)						

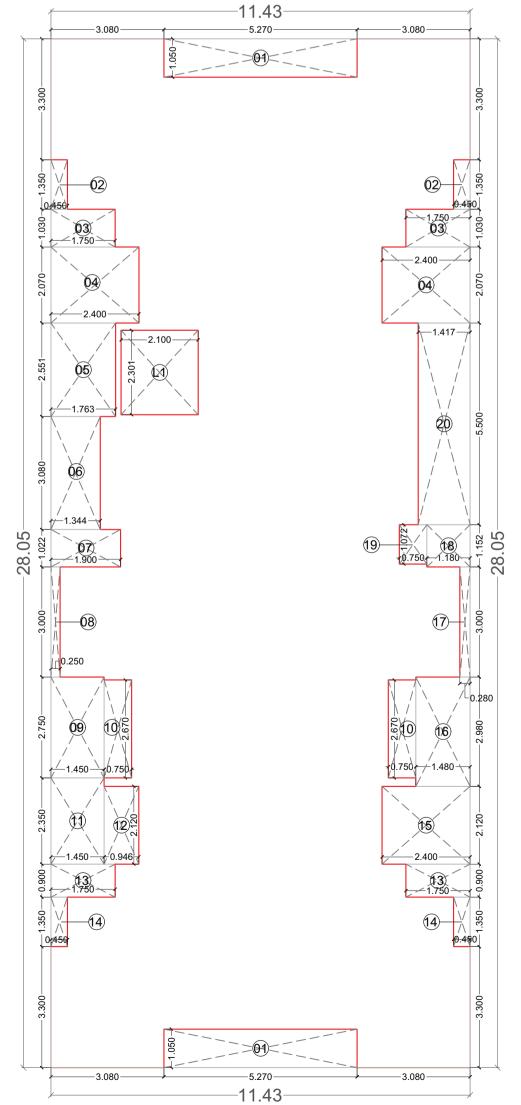

1ST, 2ND & 3RD FLOOR AREA DIAGRAM & AREA CAL. SCALE 1:100

		CONT	ENTS (OF SH	IEET					
RD	FLOOR,	LINE	DIAGR	4M 8	AREA	CALC.	&	AREA	STA	TEN

EMENT, UG 1STFLOOR PLAN, 2ND TO 3R TANK DETAILS, LIGHT VENTILATION SCHEDULE, SEPTIC PLAN CALCULATION, SEPTIC TANK DETAILS, WATER TANK CAL,.

STAMP OF APPROVAL

Document certified by BHUSHAN

ptd. 20 Oct 2022

APPROVED SUBJECT TO THE CONDITION

CIDCO/BP-18209/TPO(NM & K)/2022/9938

MENTIONED IN This Office Letter

RAMCHANDRA CHÁUDHARI

<brchaudhari@gmail.com</pre>

Name : BHUSHAN

RAMCHANDRA CI Designation Asso


SHEET NO. 2/3

N O T E 1 BOUNDRY WALL OF PLOT SHOWN BLACK. 2 PROPOSED STRUCTURE SHOWN RED. 3 ROAD SHOWN GREEN. 4 DRAINAGE LINE SHOWN RED DOTTED LINE. 5 WATER LINE SHOWN BLUE DOTTED LINE. 6 INTERNAL WALL (0.10) EXTERNAL WALL (0.15) ARCHITECT'S NAME & SIGNATURE:-			
2 PROPOSED STRUCTURE SHOWN RED. 3 ROAD SHOWN GREEN. 4 DRAINAGE LINE SHOWN RED DOTTED LINE. 5 WATER LINE SHOWN BLUE DOTTED LINE. 6 INTERNAL WALL (0.10) EXTERNAL WALL (0.15)		N O T E	NORTH
3 ROAD SHOWN GREEN. 4 DRAINAGE LINE SHOWN RED DOTTED LINE. 5 WATER LINE SHOWN BLUE DOTTED LINE. 6 INTERNAL WALL (0.10) EXTERNAL WALL (0.15)	1	BOUNDRY WALL OF PLOT SHOWN BLACK.	
4 DRAINAGE LINE SHOWN RED DOTTED LINE. 5 WATER LINE SHOWN BLUE DOTTED LINE. 6 INTERNAL WALL (0.10) EXTERNAL WALL (0.15)	2	PROPOSED STRUCTURE SHOWN RED.	
5 WATER LINE SHOWN BLUE DOTTED LINE. 6 INTERNAL WALL (0.10) EXTERNAL WALL (0.15)	3	ROAD SHOWN GREEN.	
6 INTERNAL WALL (0.10) EXTERNAL WALL (0.15)	4	DRAINAGE LINE SHOWN RED DOTTED LINE.	
	5	WATER LINE SHOWN BLUE DOTTED LINE.	1
ARCHITECT'S NAME & SIGNATURE:-	6	INTERNAL WALL (0.10) EXTERNAL WALL (0.15)	· •
	ARCHITEC	CT'S NAME & SIGNATURE:-	

CA/2013/59413 Ar.Daksha.L. Gami OWNER'S NAME & SIGNATURE :-


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	FILE NOCIDCO/BP-18	209/TPO(NM & K)/	2022			
PROJECT :-						
PROPOSED RESID	DENTIAL CUM . COMMERCIAL	BUILDING ON PLOT	-17 G, SEC - 25A ,PUSHPAK			
CHECKED BY	Ar. Daksha .L. Gami		ARCHITECT			
DRAWN BY	KOMAL		EDGE ARCHITECTS.			
SCALE	1:100	And a second	SATRA PLAZA, STUDIO NO-410, PLOT NO: 19 &20, SECTOR-19D, PALM BEACH ROAD. VASHI, NAVI MUMBAI			
DATE	18.10.2022		OFFICE: 022-27842277/ 2288			

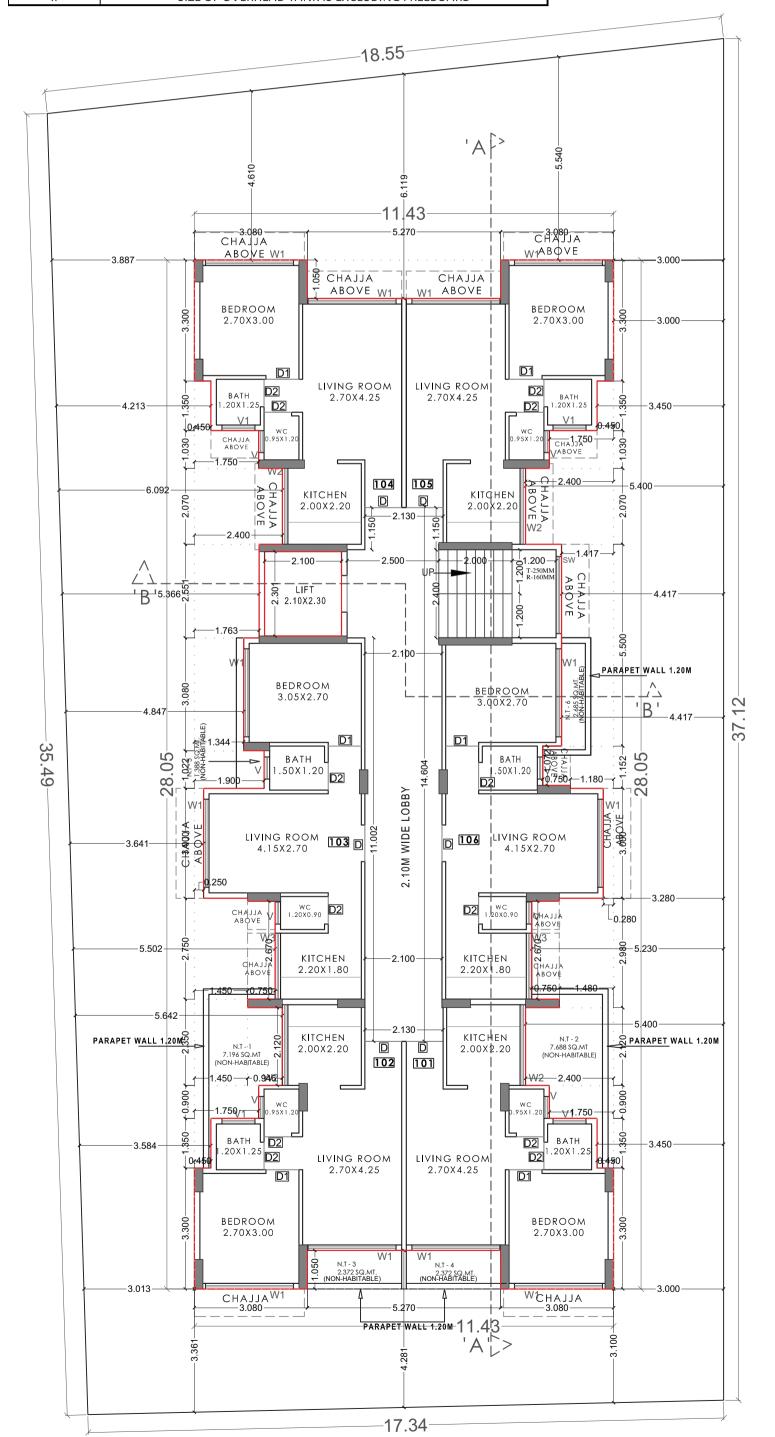

1ST FLOOR PLAN

SCALE 1:100

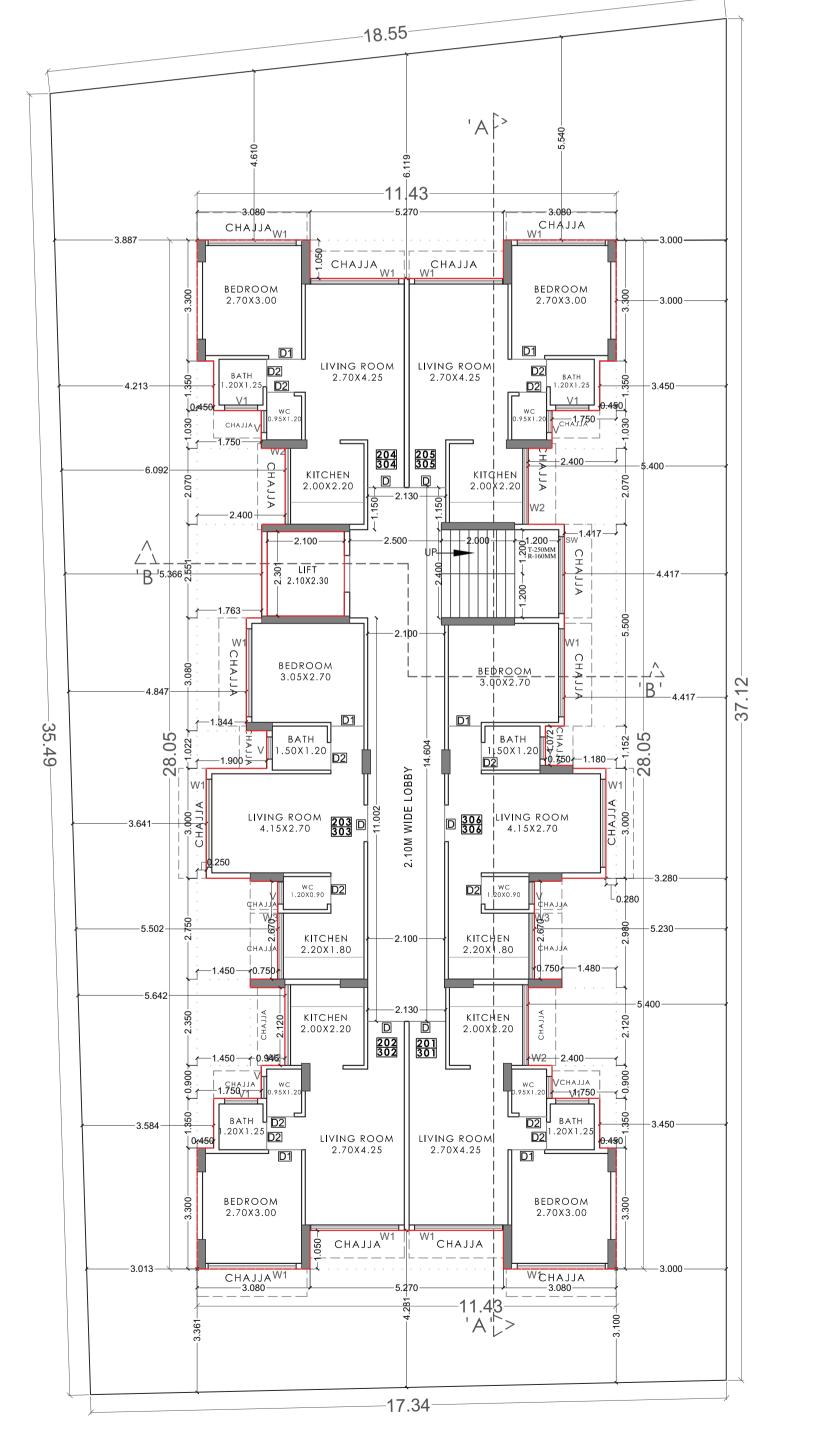

2ND AND 3RD FLOOR PLAN

SCALE 1:100

