THIS DRAWING SHALL BE READ IN CONJUNCTION WITH THE BUILDING COMPLITION CERTIFICATE

UNDER THE PROVISION OF REG. NO. 11(6) & FULL

OCCUPATION CERTIFICATE UNDER THE PROVISION

OF REG. NO. 11(7) OF D.C.P.R. 2034 ISSUED UNDER NO. P-10432/2022/(2519)/R/C WARD/EKSAR (RC)

OF ACCEPTANCE OF O.C.C./ B.C.C. BY THIS OFFICE

NO. P-10432/2022/(2519)/R/C WARD/EKSAR (RC)

PHYSICAL SIGNATURE IS REQUIRED.

THIS DRAWING IS DIGITALLY SIGNED, HENCE NO

PLANS FOR APPROVAL

E.E.(B.P.) W.S II 'R-II'

FORM 'II"

GROUND FLOOR PLAN, PLOT AREA DIAG. & CALC., BLOCK &

LOCATION PLAN, BUILT UP AREA SUMMARY, CAR PARKING

STATEMENT, SECTION THROUGH COMPOUND WALL & U.G. TANK

PROPOSED REDEVELOPMENT OF EXISTING BUILDING KNOWN

AS "BORIVALI DAULATNAGAR KIRTI CHSL" ON PLOT BEARING

CTS NO. 2519 OF VILLAGE EKSAR OF DAULAT NAGAR BORIVALI

A.E.(B.P.) R-II WARD

OWNER / DEVELOPER

ACCEPTED AS COMPLETION PLANS AS ACCOMPANIMENT

SIGNED ON EVEN DATE

LETTER UNDER EVEN

S.E.(B.P.) R2

KRISHNA H. MAKHELA

(LICENSED SURVEYOR)

LICENCE NO: M / 440 /LS

CONTENTS OF SHEET

TABLE - A & TABLE NO. V.

NAME & ADDRESS OF OWNER

SHRI. SAHIL M. VIRANI

IN SQ.MTS.

334.40

NIL

334.40

334.40

1.00

334.40

NIL

167.20

167.20

2.00

2.00

668.37

233.93

107.47

902.88

902.30

18.00 Nos.

6.25 Nos.

0.62 Nos.

NIL

7.00 Nos.


12.00 Nos.

00.00 Nos.

N.A.

SIGNATURE OF LICENCED SURVEYOR

MCGM FILE NO.

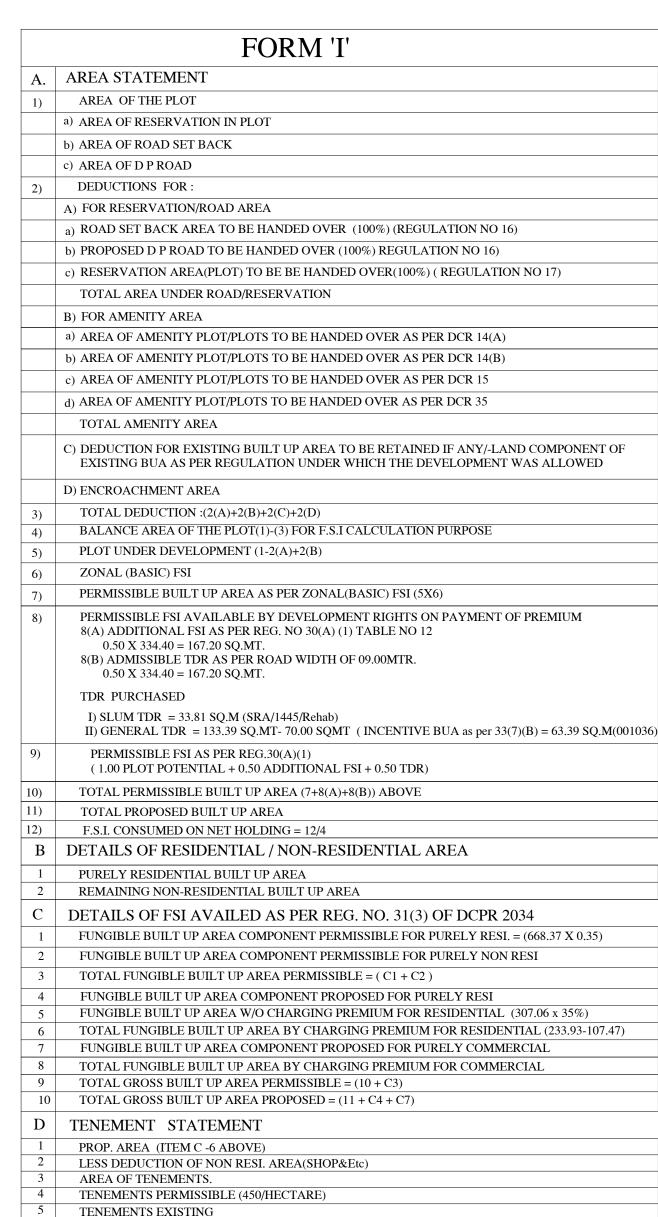

TENEMENTS PROPOSED

7 TOTAL TENEMENTS (5+6)

SHOPS

E | PARKING STATEMENT

OUTSIDERS (VISITORS)

4 TOTAL PARKING PROVIDED

5 PARKING TO BE CONDONED

TOTAL PARKING EXISTING

TOTAL PARKING REOUIRED

1 LOADING & UNLOADING REQUIRED

2 TOTAL LOADING UNLOADING PROVIDED

TOTAL PARKING REQUIRED BY REGULATIONS

F LOADING & UNLOADING STATEMENT

CERTIFICATE OF AREA

ON SITE AND THE AREA SO WORKED OUT IS i.e. 334.40 SQ.MTS.

(THREE HUNDRED ANDTHIRTY FOUR POINT FOUR ZERO SQ.MTS.) AND

CERTIFIED THAT I HAVE SURVEYED THE PLOT UNDER REFERENCE ON AND THAT

THE DIMENSIONS OF SIDES, ETC. OF THE PLOT STATED ON PLAN ARE AS MEASURED

D.P. TALLIES WITH THE AREA STATED IN THE DOCUMENT OF OWNERSHIP / RECORDS

0.00 201, TANISHKA COMMERCIAL PREMISES, 902.30 AKURLI ROAD ,W,E. HIGHWAY, KANDIVALI 40.60 (EAST) 4000101. 09.00 09.00 Nos.

B.M.C.

DRG. N

(EAST), MUMBAI

NAME ADDRESS OF R.C.C. CONSULTANT SHRI. ABHIJIT VINOD PHATARPEKAR

DESCRIPTION OF PROP./ PROPERTY

1201, AA WING, NL ARYAVARTA NL COMPLEX, ANAND NAGAR, DAHISAR (EAST) MUMBAI -


NAME & ADDRESS OF LICENSED SURVEYOR

KEYARCH

339, 3RD FLOOR, V-MALL THAKUR COMPLEX, ASHA NAGAR ROAD, KANDIVALI (EAST), MUMBAI - 400 101.

KRISHNA H. MAKHELA (LICENSED SURVEYOR) LICENCE NO: M / 440 /LS

M.C. FILE NO.	P-10432/2022/(2519)/R/C WARD/EKSAR (RC)							
RG. NO.	JOB NO.	FILE NAME	DRG. BY					
01			SAGAR					

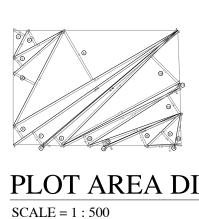

PLOT AREA DIAG.

1	1/2	Χ	4.00	Χ	1.63	X 1 NO	=	3.26	SQ.N
2	1/2	Χ	7.47	Χ	2.22	X 1 NO	=	8.29	SQ.N
3	1/2	Χ	8.72	Χ	1.63	X 1 NO	=	7.10	SQ.N
4	1/2	Χ	14.21	Χ	3.19	X 1 NO	=	22.66	SQ.N
5	1/2	Χ	25.18	Χ	7.61	X 1 NO	=	95.81	SQ.N
6	1/2	Χ	26.52	Χ	2.06	X 1 NO	=	27.32	SQ.N
7	1/2	Χ	26.52	Χ	2.18	X 1 NO	=	28.91	SQ.N
8	1/2	Χ	23.48	Χ	0.12	X 1 NO	=	1.41	SQ.N
9	1/2	Χ	23.48	Χ	1.71	X 1 NO	=	20.08	SQ.N
10	1/2	Χ	21.50	Χ	5.12	X 1 NO	=	55.04	SQ.N
11	1/2	Χ	17.53	Χ	0.54	X 1 NO	=	4.73	SQ.N
12	1/2	Χ	17.27	Χ	1.55	X 1 NO	=	13.38	SQ.N
13	1/2	Χ	14.18	Χ	2.88	X 1 NO	=	20.42	SQ.N
14	1/2	Χ	12.75	Χ	0.75	X 1 NO	=	4.78	SQ.N
15	1/2	Χ	10.76	Χ	0.06	X 1 NO	=	0.32	SQ.N
16	1/2	Χ	10.76	Χ	2.12	X 1 NO	=	11.41	SQ.N
17	1/2	Χ	6.17	Χ	2.46	X 1 NO	=	7.59	SQ.N
18	1/2	Χ	3.72	Χ	0.12	X 1 NO	=	0.22	SQ.N
19	1/2	Χ	4.18	Χ	0.80	X 1 NO	=	1.67	SQ.N
					TOTAL	ADDITION	=	334.40	SQ.N

9		1/2	Χ	23.48	Χ	1.71	X 1 N	10	=	20.0	80	SC	
10		1/2	Х	21.50	Х	5.12	X 1 N	10	=	55.0	04	SC	
11		1/2	Х	17.53	Х	0.54	X 1 N	10	=	4.7	73	SC	
12		1/2	Х	17.27	Х	1.55	X 1 N	10	=	13.3	38	SC	
13		1/2	Χ	14.18	Χ	2.88	X 1 N	10	=	20.4	42	SC	
14		1/2	Χ	12.75	Χ	0.75	X 1 N	10	=	4.7	78	SC	
15		1/2	Χ	10.76	Χ	0.06	X 1 N	10	=	0.0	32	SC	
16		1/2	Χ	10.76	Χ	2.12	X 1 N	10	=	11.4	41	SC	
17		1/2	Χ	6.17	Χ	2.46	X 1 N	10	=	7.5	59	SC	
18		1/2	Χ	3.72	Χ	0.12	X 1 N	10	=	0.2	22	SC	
19		1/2	Χ	4.18	Χ	0.80	X 1 N	10	=	1.6	67	SC	
						TOTAL	ADDIT	ΓΙΟΝ	=	334.4	40	SC	
	Computation of Incentive BUA for proposal under Reg. No. 33 (7)(B) SR. Description BUA in sq.mt.												
	NO. 1.	xisting otal C	307.06 SQ.MT.										
	2. 15% incentive BUA on 1 above							46.06 SQ.MT.					
	3.	of Res appro emen	09.0	0 Nos									

07.00 Nos.

90.00 SQ.MT

70.00 Nos.

70.00 SQ.MT.

As per assessment abstract no. of

(Sr. no. 3 x 10)

Tenements (Sr. no. 3a x 10)

Permissible insentive BUA

Sr. No. 2 & 4a above

Incentive BUA based on No of Residential


Note: Proposal submitted after 27 05 2016 are eligible for incentive


Note: - Proposal submitted after 27.05.2016 are eligible for incentive FSI under Reg. No. 33 (7)B
<u>SITE</u> U/R
AATHA LIFECARE PRATETHAN ANTINALIFECARE MECCA. GATHE MECCA. GATHE AMANASSIA METERATY A MICHAEL SIGNAM MICHAEL SIGN
LOCATION PLAN

LOCATION PLAN	
SCALE = 1 : 4000	

\wedge	E	NORTH 3.00M WIDE DRIVEWAY
— 9.00 M WIDE EXISTING ROAD	OS:E LS∃M M.S. CHAIN GATE ENTRY/EXIT ENTRY/EXIT	3 3 1 1 1 1 1 1 1 1 1 1 1 1 1 1 1 1 1 1
\bigvee	1	SOUTH


GROUND FLOOR PLAN

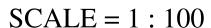

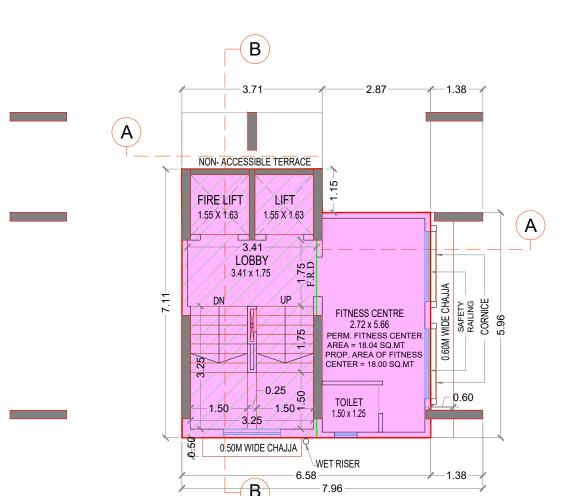


1ST FLOOR PLAN

SCALE = 1:100

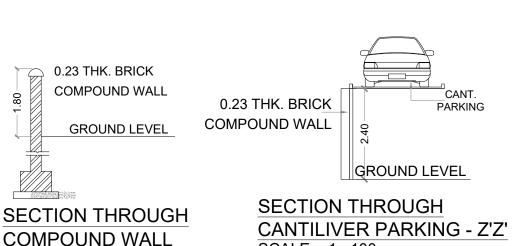

SCALE = 1 : 100

SCALE 1:100

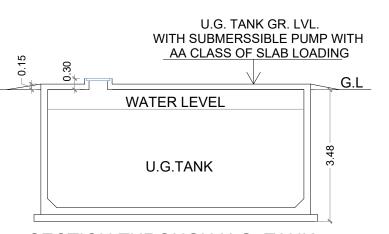

SECTION THROUGH U.G. TANK **SCALE 1:100**

TABLE - A

(PERMISSIBLE FSI)

ARFA IN

SQ.MTS

334.40

167.20

167.20

668.80

233.93

233.93

902.88

DESCRIPTION

NET AREA OF THE PLOT

TOTAL PERMISSIBLE B.U.A.

(35 % X 668.80)

AREA KEPT IN ABEYANCE

TOTAL PERMISSIBLE FCFSI

GROSS PERMISSIBLE FSI

PROPOSED B.U.A.

(TABLE NO.2)

BLOCK PLAN (**)

ADDITIONAL FSI



0.30 0.23 0.30 A

AREA LINE DIAG. 2ND FLOOR PLAN **SCALE 1:100**

 A_{i}

BUILT UP AREA CALCULATION

MCGM FILE NO.

2ND FLC	2ND FLOOR												
A	12.51	Х	9.11 X	1 NO	=	113.97	SQ.MT.						
В	0.23	Х	1.00 X	1 NO	=	0.23	SQ.MT.						
		=	114.20	SQ.MT.									


DEDUCTIONS

1	0.30	Х	2.92	Χ	1 NO	=	0.88	SQ.MT.
2	0.30	Х	5.50	Χ	1 NO	=	1.65	SQ.MT.
3	5.61	Х	2.00	Χ	1 NO	=	11.22	SQ.MT.
		=	13.75	SQ.MT.Y				
TOTAL B	BUILT UP AF	=	100.45	SQ.MT.X				

STAIRCASE AREA CALCULATION

2ND FLO	OR									
ST1	3.41	Х	7.11	Х	1 NO		=	24.25	SQ.MT	_
TOTAL STAIRCASE AREA (2ND FLOOR)						=	24.25	SQ.MT	. Y2	

NET BUILT UP AREA	=	76.20	SQ.MT.
[X1 - Y2]			

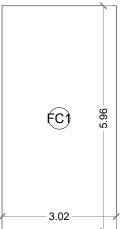

LINE AREA DIAGRAM FITNESS CENTER

SCALE 1:100

STATEMENT OF PERMISSIBLE FITNESS CENTER AREA

PERMISSIBLE FITNESS CENTER AREA = 2% OF TOTAL BUA (F.S.I) _ <u>2 X 902.30</u> SQ.MT

PERMISSIBLE FITNESS CENTER AREA = 18.04 SQ.MT PROPOSED AREA OF FITNESS CENTER = 18.00 SQ.MT FITNESS CENTER AREA CALCULATION

1ST FLO	OR				
FC1	3.02	Х	5.96 X 1 NO	=	18.00 SQ.MT.
			TOTAL ADDITION	I =	18.00 SO MT

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ACCEPTED AS COMPLETION PLANS AS ACCOMPANIMENT OF ACCEPTANCE OF O.C.C./ B.C.C. BY THIS OFFICE LETTER UNDER EVEN

NO. P-10432/2022/(2519)/R/C WARD/EKSAR (RC)

THIS DRAWING IS DIGITALLY SIGNED, HENCE NO PHYSICAL SIGNATURE IS REQUIRED.

BUILT UP AREA CALCULATION 3RD TO 5TH FLOOR

≠ 0.90 ₹

 $(3)|^{\aleph}$

Α	14.11	Χ	9.11 X 1 NO	=	128.54	SQ.MT.
			TOTAL ADDITION	=	128.54	SQ.MT.X
DEDUCT	IONS					

DEDUCT	IONO							
1	0.90	Х	5.50	Χ	1 NO	=	4.95	SQ.MT.
2	0.65	Х	0.23	Χ	1 NO	=	0.15	SQ.MT.
3	0.90	Х	5.73	Χ	1 NO	=	5.16	SQ.MT.
		EDUCTION	=	10.26	SQ.MT.Y			
TOTAL B	UILT UP AF	=	118.28	SQ.MT.				

STAIRCASE AREA CALCULATION


3RD TO 5TH FLOOR	

NET BUILT UP AREA

[X1 - Y2]

3RD TO 5TH FLOOR										
ST1	3.41	Χ	6.96	Χ	1 NO	=	23.73	SQ.MT	_	
TOTAL S	TAIRCASE	=	23.73	SQ.MT	. Y2					

94.55 SQ.MT.

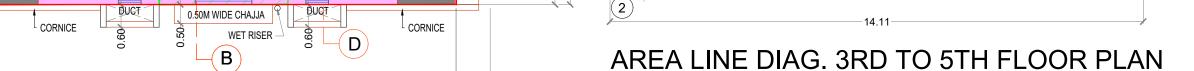

SCALE 1:100

∤ 0.90 **⊀**

3RD TO 5TH FLOOR PLAN

0.50M/WIDE CHAJJA 0.50M WIDE CHAJJA

FIRE

1.55 X 1.63

2.73 x 1.85

1,55 X 1.63

TOILET 1.25 x 1.85

4.15 x 2.76 RERA AREA - 42.72 SQ.MT.

BED ROOM 2.75 x 2.85

≠ 0.90 **≠**

2.30 x 1.10

1.40 x 0.90

TOILET

BED ROOM 2.60 x 3.00

SCALE = 1:100

0.60 🖈


SCALE = 1 : 100

TOILET 1.25 x 1.85

4.15 x 2.76 RERA AREA - 42.72 SQ.MT.

2.30 x 1.10

1.40 x 0.90

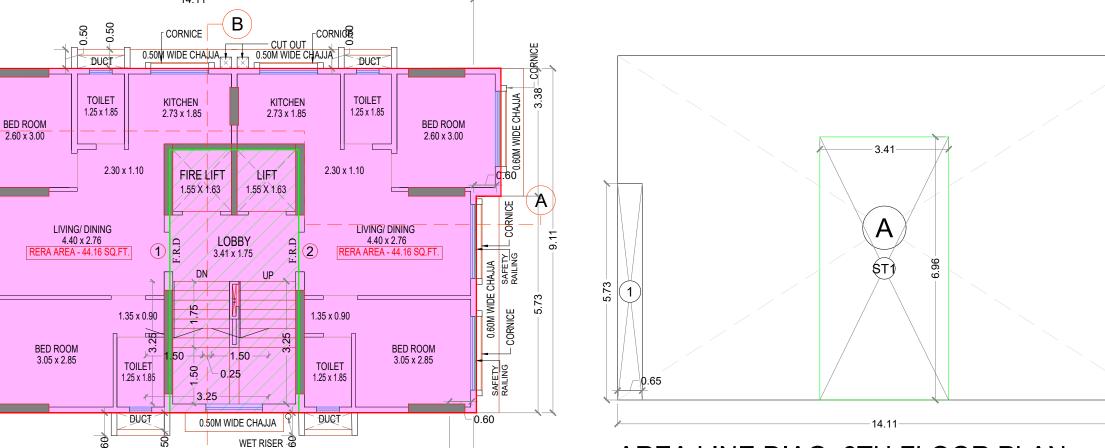

AREA LINE DIAG. 6TH FLOOR PLAN SCALE 1:100

BUILT UP AREA CALCULATION

6TH FLO	OR							
Α	14.11	Х	9.11	Χ	1 NO	=	128.54	SQ.MT.
	TOTAL ADDITION						128.54	SQ.MT.

DEDUCTIONS

1	0.65	Χ	5.73	Χ	2 NOS	=	7.45 SQ.MT.
			TOTA	۱L D	EDUCTION	=	7.45 SQ.MT. Y1
TOTAL BUILT UP AREA [X - Y1]							121.09 SQ.MT.X1

STAIRCASE AREA CALCULATION

									00.14	l
TOTAL STAIRCASE AREA (6TH FLOOR)							=	23.73	SQ.MT	. Y2
ST1	3.41	Χ	6.96	Χ	1	NO	=	23.73	SQ.MT	
6TH FLO	OR									

NET BUILT UP AREA	=	97.36	SQ.N
[X1 - Y2]			

PLANS FOR APPROVAL

E.E.(B.P.) W.S II 'R-II'

S.E.(B.P.) R2	A.E.(B.P.) R-II WARD

KRISHNA H. MAKHELA (LICENSED SURVEYOR)

OWNER / DEVELOPER LICENCE NO: M / 440 /LŚ

FORM 'II"

CONTENTS OF SHEET

2ND, 3RD TO 5TH & 6TH FLOOR PLAN, BUILT UP AREA DIAGRAM & CALCULATION, FITNESS CENTER AREA DIAG. & CALCULATION.

DESCRIPTION OF PROP./ PROPERTY

PROPOSED REDEVELOPMENT OF EXISTING BUILDING KNOWN AS "BORIVALI DAULATNAGAR KIRTI CHSL" ON PLOT BEARING CTS NO. 2519 OF VILLAGE EKSAR OF DAULAT NAGAR BORIVALI (EAST), MUMBAI

NAME & ADDRESS OF OWNER

SHRI. SAHIL M. VIRANI

201, TANISHKA COMMERCIAL PREMISES, AKURLI ROAD, W,E. HIGHWAY, KANDIVALI

(EAST) 4000101. NAME ADDRESS OF R.C.C. CONSULTANT

SHRI. ABHIJIT VINOD PHATARPEKAR

1201, AA WING, NL ARYAVARTA NL COMPLEX, ANAND NAGAR, DAHISAR (EAST) MUMBAI -400068.

NAME & ADDRESS OF LICENSED SURVEYOR


KEYARCH

339, 3RD FLOOR, V-MALL, THAKUR COMPLEX, ASHA NAGAR ROAD, KANDIVALI (EAST), MUMBAI - 400 101.



B.M.C. FILE NO.	P-10432/2022/(2519)/R/C WARD/EKSAR (RC)							
DRG. NO.	JOB NO.	FILE NAME	DRG. BY	Y ARG				
02			SAGAR	:KA				

6TH FLOOR PLAN SCALE = 1 : 100

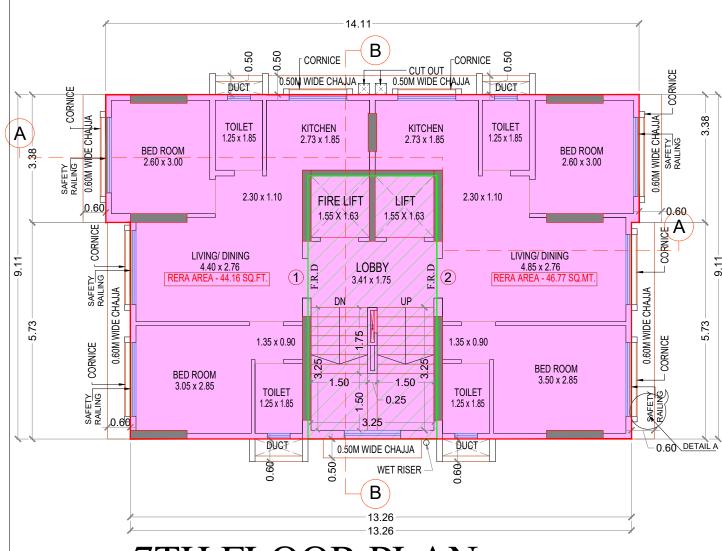

A

AREA LINE DIAG. 7TH FLOOR PLAN SCALE 1:100

BUILT UP AREA CALCULATION

/ IH FLO	OR				
A	14.11	Х	9.11 X 1 NO	=	128.54 SQ.MT.
			TOTAL ADDITION	=	128.54 SQ.MT.X
DEDUCT					

DEDUCTIONS	

MCGM FILE NO.

DEDUCT	IONS								
1	0.65	Х	5.73	Χ	1 NO	=	3.72	SQ.MT	
2	0.20	Х	5.73	Χ	1 NO	=	1.15	SQ.MT	
		=	4.87	SQ.MT	.Y1				
TOTAL E	BUILT UP AF	=	123.67	SQ.MT	. X1				

STAIRCASE AREA CALCULATION

BUILT UP AREA CALCULATION

TOTAL BUILT UP AREA [X - Y1]

STAIRCASE AREA CALCULATION

8TH TO 10TH FLOOR

NET BUILT UP AREA

[X1 - Y2]

15.36 X 9.11 X 1 NO

0.20 X 5.73 X 1 NO

3.41 X 6.96 X 1 NO

TOTAL STAIRCASE AREA (8TH TO 10TH FLOOR)

TOTAL ADDITION

TOTAL DEDUCTION

TOILET

139.93 SQ.MT

139.93 SQ.MT.X

1.15 SQ.MT.

1.15 SQ.MT.Y1

138.78 SQ.MT.X1

23.73 SQ.MT

115.05 SQ.MT.

4TH FLR.


23.73 SQ.MT. Y2

8TH TO 10TH FLOOR

DEDUCTIONS

STAIRCA	STAIRCASE AREA CALCULATION											
7TH FLO	OR											
ST1	3.41	Х	6.96	Χ	1 NO		=	23.73	SQ.MT.			
TOTAL S	TOTAL STAIRCASE AREA (7TH FLOOR)						II	23.73	SQ.MT.			

NET BUILT UP AREA	=	99.94 SQ.MT.
[X1 - Y2]		

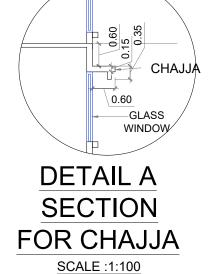

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PLANS FOR APPROVAL

E.E.(B.P.) W.S II 'R-II'

S.E.(B.P.) R2	A.E.(B.P.) R-II WARD

KRISHNA H. MAKHELA (LICENSED SURVEYOR)

LICENCE NO: M / 440 /LS

OWNER / DEVELOPER

FORM 'II"

CONTENTS OF SHEET

7TH, 8TH TO 10TH & TERRACE FLOOR PLAN, BUILT UP AREA DIAGRAM & CALCULATION WITH STAIRCASE AREA CALCULATION.

DESCRIPTION OF PROP./ PROPERTY

PROPOSED REDEVELOPMENT OF EXISTING BUILDING KNOWN AS "BORIVALI DAULATNAGAR KIRTI CHSL" ON PLOT BEARING CTS NO. 2519 OF VILLAGE EKSAR OF DAULAT NAGAR BORIVALI (EAST), MUMBAI

NAME & ADDRESS OF OWNER SHRI. SAHIL M. VIRANI

201, TANISHKA COMMERCIAL PREMISES, AKURLI ROAD, W,E. HIGHWAY, KANDIVALI

(EAST) 4000101. NAME ADDRESS OF R.C.C. CONSULTANT SHRI. ABHIJIT VINOD PHATARPEKAR

1201, AA WING, NL ARYAVARTA NL COMPLEX, ANAND NAGAR, DAHISAR (EAST) MUMBAI -

NAME & ADDRESS OF LICENSED SURVEYOR

KEYARCH


339, 3RD FLOOR, V-MALL, THAKUR COMPLEX, ASHA NAGAR ROAD, KANDIVALI (EAST), MUMBAI - 400 101.




B.M.C. FILE NO.	P-10432/2022/(2519)/R/C WARD/EKSAR (RC)						
DRG. NO.	JOB NO.	FILE NAME	DRG. BY				
03			SAGAR				

7TH FLOOR PLAN


SCALE = 1:100

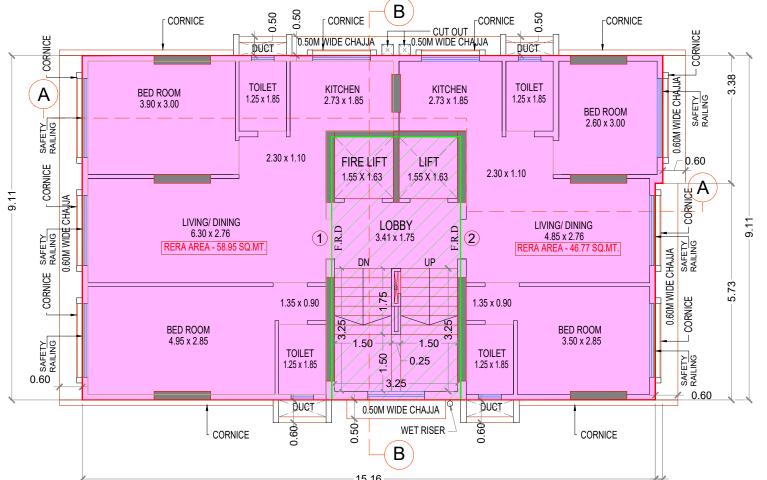

8TH TO 10TH FLOOR PLAN

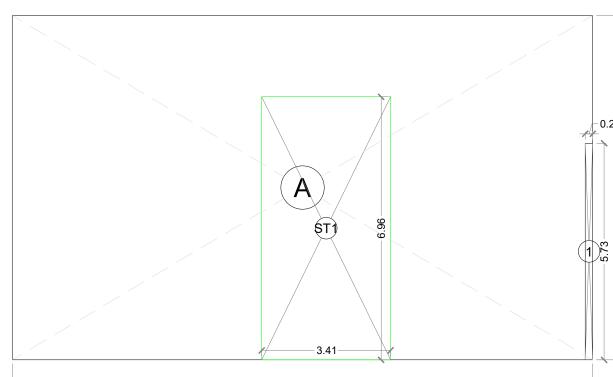

AREA LINE DIAG. 8TH TO 10TH FLOOR PLAN **SCALE 1:100**

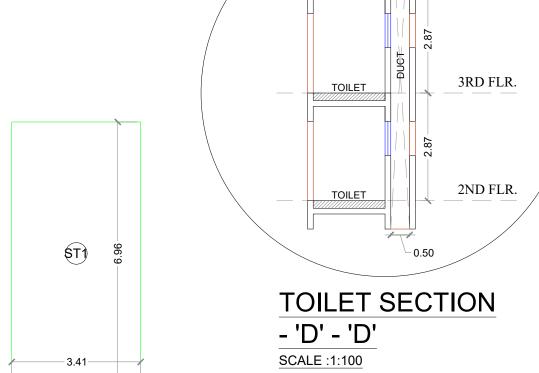

2ND FLOOR STAIRCASE, LIFT LOBBY AREA DIA.

STAIRCASE & LIFT LOBBY AREA CALCULATION

(T) =

2ND FLO	OR							
ST1	3.41	Х	7.11	Χ	1 NO	=	24.25	SQ.M
			TO	TAL	ADDITION	=	24.25	SQ.M

3RD TO 10TH FLOOR STAIRCASE, LIFT LOBBY AREA DIA.

STAIRCASE & LIFT LOBBY AREA CALCULATION

3RD TO	10TH FLOO	R						
ST1	3.41	Х	6.96	Χ	1 NO	=	23.73	SQ.M
			TC	OTAL	ADDITION	=	23.73	SQ.M

0.50M WIDE CHAJJA BELOW (A UP FOR THE LMR LIFT FIRELIFT MS LADDER" 1.55 X 1.63 RRACE ABOVE 10 TH FLOOR OPEN TO SKY JĚRRĂCĚ ABOVĚ 10 TH FLŎOŘ LOBBY OPEN TO SKY RACE GARDEN OPEN TO SKY OVER HEAD WATER ŢĔŖŖĄĊĔ ĠĄŖĎĘŊ QPĘŊ TŲ SĶY TANK ABOVE 1.50 - 1.50 −0.25 ` 1:50 M, HT, PARAPET WALL PARAPET WALL 0.50M WIDE CHAJJA WET RISER

TERRACE FLOOR PLAN

SCALE = 1:100

SCALE = 1:100

TABLE NO. IV

% Ratio to Total

					ING SPACES	STATEMENT					
			Carpet Area Tenemrnt in		No. of	No. of Tene	ments in Group of	f Required Parking S	paces	Total	
SR. 10.	Wing	Floor	Flat no. 1	Flat no. 2	Tenements proposed per floor	Below 45 sq.mt.	Above 45 to 60 sq.mt.	Above 60 to 90 sq.mt.	Above 90	Parking	
					per noor	(1 for 4 T/S)	(1 for 2 T/S)	(1 for EVERY T/S)	(2 for 1 T/S)		
(1)	(2)	(3)	(4)	(5)	(5)	(6)	(7)	(8)	(9)	(10)	
1	(A) Resider	ntial :-									
	А	Gr									
		1st									
		2nd	34.08	34.08	2	2					
		3rd	42.72	42.72	2	2					
		4th	42.72	42.72	2	2					
		5th	42.72	42.72	2	2					
		6th	44.16	44.16	2	2					
		7th	44.16	46.77	2	1	1				
		8th	58.95	46.77	2		2				
		9th	58.95	46.77	2		2				
		10th 58.95 46.77 2		2		2					
2	Total Resid	lential Teneme	ets (for Tenem	ents Density)	18	11	07				
3	Required P	arking Spaces	(From 2 abov	/e)		2.75	3.50			6.25	
4	10% Visitor	s Parking(3)	(10%)							0.62	
5	Total Requ	ired Parking S	paces for Resi	dential (3 + 4)					6.87	
6	Total Parkii	ng Spaces Pe	rmissible (Ten	ements wise &	shall not be n	nore than nos. of T	7/S)			6.87	
7	Maximum f	ree permissibl	e parking					0.00 sq.m + Parking 0.00 sq.mt + Sr. no. 9			
8	50% of Ad	ditional Parki	ng Spaces = 0	5.87 x 50%						3.43	
9	Total Requ	ired Parking	Spaces Requi	red (6 + 8 = 1	0.30) sc	ay - 10 nos.				10.00	
10	Total Requ	ired Parking	Spaces Provid	ded						12.00	
12	DETAILES C	F PARKING S	PACES PROVI	DED							
	Sr	. no.		Floor			Parking Space	s Provided			
						Small	Е	Big	Total		
		1		(Surface Parki	<u> </u>	3.00			3.00		
		1	Stilt (Stack Parkir		1)	2.00		.00	6.00		
		6	Canti	iliver Parking		1.00	2	2.00	3.00		

6.00

50.00%

6.00

50.00%

12.00

			PROF	OSED BUILT U	AREA STATE	MENT			
			Proposed Bu	ilt Up Area (in	sq.mt.)	Staircase / Lif	t / I ift	Flat /	NR / Society Office/
SR. NO.	Wing	Floor		residential		Lobby Area (Refuge Area	
						Resider	ntial	-	
(1)	(2)	(3)		(4)		(5)			(6)
1		Gr							
Α		1st					,		
		2nd		76.20		24.2	5		
		3rd		94.55		23.7	3		
		4th		94.55		23.7	3		
		5th		94.55		23.7	3		
		6th		97.36		23.7	3		
		7th		99.94		23.7	3		
		8th		115.05		23.7	3		
		9th		115.05		23.7	3		
		10th		115.05		23.7	3		
2	Total BU	A Proposed		902.30		214.0)9		
3	Fungible Area	e Componsatory a Proposed :		233.93					
4	Net BUA	A Proposed		902.30					
5	Fitnes	s Centre	Permissible 2 Provided	2 x 2% = =	18.04 18.00			Provi	ded at 1st Floor
6	Socie	ty Office	Permissible Provided	=	20 Sq.mt. N.A.				
7		Area / BUA in sq.mt (g 14A OR 14B)	Permissible Provided	= =	N.A.				
8	IH/PH	provided	Permissible Provided BU		N.A.				
9	9 Refuge Area		Required (in Sq.mt.)	Provided (in Sq.mt.)	Excess Provided	Proposed at floor		R REF	ISIDERED JGE AREA Total BUA

-UN	IGIBL	E COMPENSATORY AREA STATEMENT				
R. O.		Description	В	SUA in sq.mt.		
	(A)	REHAB COMPONENT	Commercial	Residential	Total	
1.	Exi	sting BUA of building to be demolished:				
	а	Commercial structure existing prior to 01-04-1962				
	b	Residential structure existing prior to 17-04-1964				
	С	As per OC Plans/BCC Plan Approved u/nodtd				
	d	As as per full O.C granted u/no. CE/3136/BSII/A/R dt. 06/04/1979 and B.C.C granted vide file no. CE/3136/BSII/A/R dt. 04/08/1979.		336.70 sq.mt.		
	е	Others Specify				
	f	Existing BUA excluding staircase / lift / lift lobby / ottla of the building to be demolished as per redrafted plan out of (a) or (b) or (c) or (d) or (e)		307.06 sq.mt.		
	g	Existing BUA accepted for allowing fungible area for Rehab without charging premium from above		307.06 sq.mt.		
2.	Pern	nissible fungible area for rehab without charging premium [35% of 1(g) above] = (3+4)		107.47sq.mt.		
3.		Fungible Area availed for Rehab Component = ol. no.14 - Col. no.15 - Col. no.7 of Table no II)				
4.	Fung	gible Area kept in abeyance / utilized (As per Total of Col. no.16 of Table no II)				
	(B)	SALE COMPONENT				
5.	Peri	missible BUA	Net Plot Area	50% add FSI	0.50 TDR	Total
			334.40sq.mt.	167.20sq.mt.	167.20 sq.mt.	668.80 sq.mt.
6.	Net	Built up area proposed (Sr. no. 4 of Table no.	Commercial	Residential	Total	
		- 1)		902.30sq.mt.	902.30sc	
7.	Р	ermissible Fungible Area (0.35 x Sr. no. 6)		233.93sq.mt.	233.93s	q.mt.
8.	F	ungible Area availed for sale component (7-2)		126.46sq.mt.	126.46s	q.mt.

THIS DRAWING SHALL BE READ IN CONJUNCTION WITH THE BUILDING COMPLITION CERTIFICATE UNDER THE PROVISION OF REG. NO. 11(6) & FULL OCCUPATION CERTIFICATE UNDER THE PROVISION OF REG. NO. 11(7) OF D.C.P.R. 2034 ISSUED UNDER NO. P-10432/2022/(2519)/R/C WARD/EKSAR (RC) SIGNED ON EVEN DATE

ACCEPTED AS COMPLETION PLANS AS ACCOMPANIMENT OF ACCEPTANCE OF O.C.C./ B.C.C. BY THIS OFFICE LETTER UNDER EVEN NO. P-10432/2022/(2519)/R/C WARD/EKSAR (RC)

THIS DRAWING IS DIGITALLY SIGNED, HENCE NO PHYSICAL SIGNATURE IS REQUIRED.

PLANS FOR APPROVAL

E.E.(B.P.) W.S II 'R-II'

KRISHNA H. MAKHELA

(LICENSED SURVEYOR)

LICENCE NO: M / 440 /LS

S.E.(B.P.) R/C WARD

OWNER / DEVELOPER

A.E.(B.P.) R-II WARD

FORM 'II"

CONTENTS OF SHEET

TABLE NO. I, III & IV.

DESCRIPTION OF PROP./ PROPERTY

PROPOSED REDEVELOPMENT OF EXISTING BUILDING KNOWN AS "BORIVALI DAULATNAGAR KIRTI CHSL" ON PLOT BEARING CTS NO. 2519 OF VILLAGE EKSAR OF DAULAT NAGAR BORIVALI (EAST), MUMBAI

NAME & ADDRESS OF OWNER

SHRI. SAHIL M. VIRANI

201, TANISHKA COMMERCIAL PREMISES, AKURLI ROAD ,W,E. HIGHWAY, KANDIVALI (EAST) 4000101.

NAME ADDRESS OF R.C.C. CONSULTANT SHRI. ABHIJIT VINOD PHATARPEKAR

1201, AA WING, NL ARYAVARTA NL COMPLEX, ANAND NAGAR, DAHISAR (EAST) MUMBAI -

NAME & ADDRESS OF LICENSED SURVEYOR

KEYARCH


339, 3RD FLOOR, V-MALL, THAKUR COMPLEX, ASHA NAGAR ROAD, KANDIVALI (EAST), MUMBAI - 400 101.



B.M.C. FILE NO.	P-10432/2022/(2519)/R/C WARD/EKSAR (RC)							
DRG. NO.	JOB NO.	FILE NAME	DRG. BY					
04			SAGAR					

MCGM FILE NO.


P-10432/2022/(2519)/R/C WARD/EKSAR (RC)

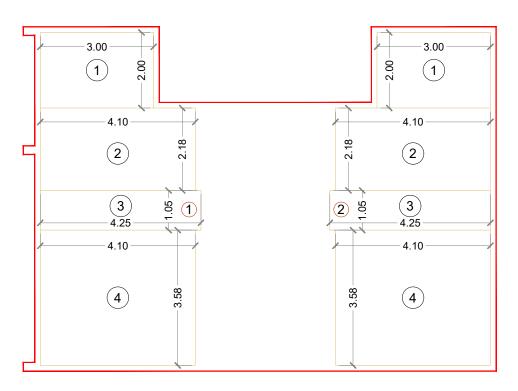

AREA LINE DIAG. 2ND FLOOR (FLAT No. 1 & 2) SCALE 1:100

RERA CARPET AREA CALCULATION

1ST FLO	OR (FLAT	No. 1	&2)					2 NOS
1	3.00	Х	2.00	Χ	1 NO	=	6.00	SQ.MT.
2	4.10	Х	2.18	Χ	1 NO	=	8.94	SQ.MT.
3	4.25	Х	1.05	Χ	1 NO	=	4.46	SQ.MT.
4	4.10	Х	3.58	Χ	1 NO	=	14.68	SQ.MT.
		=	34.08	SQ.MT.				

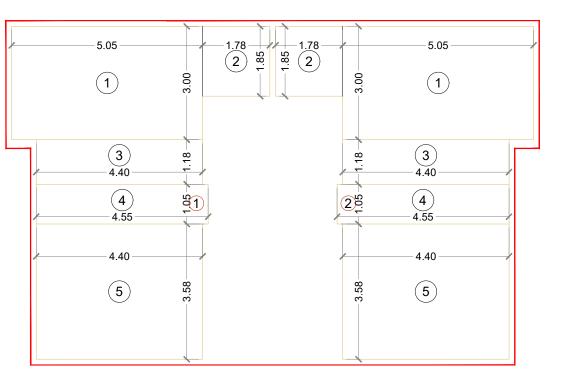


AREA LINE DIAG. 6TH FLOOR (FLAT No. 1 & 2)

SCALE 1:100

RERA CARPET AREA CALCULATION

6TH & 7T	H FLOOR	(FLA	T No. 1	& 2))			3 NOS
1	5.05	Χ	3.00	Χ	1 NO	=	15.15	SQ.MT.
2	1.78	Х	1.85	Χ	1 NO	=	3.29	SQ.MT.
3	4.40	Χ	1.18	Χ	1 NO	=	5.19	SQ.MT.
4	4.55	Х	1.05	Χ	1 NO	=	4.78	SQ.MT.
5	4.40	Χ	3.58	Χ	1 NO	=	15.75	SQ.MT.
		. ADDITION	=	44.16	SQ.MT.			

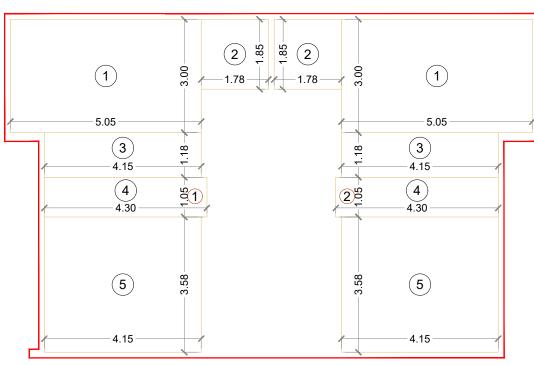


AREA LINE DIAG.3RD TO 5TH FLOOR (FLAT No. 1 & 2)

SCALE 1:100

RERA CARPET AREA CALCULATION

3RD TO 5TH FLOOR (FLAT No. 1 & 2)								6 NOS	
1		5.05	Х	3.00	Χ	1 NO	=	15.15	SQ.MT.
2		1.78	Х	1.85	Χ	1 NO	=	3.29	SQ.MT.
3		4.15	Х	1.18	Χ	1 NO	=	4.90	SQ.MT.
4		4.30	Х	1.05	Χ	1 NO	=	4.52	SQ.MT.
5		4.15	Х	3.58	Χ	1 NO	=	14.86	SQ.MT.
TOTAL ADDITION							=	42.72	SQ.MT.

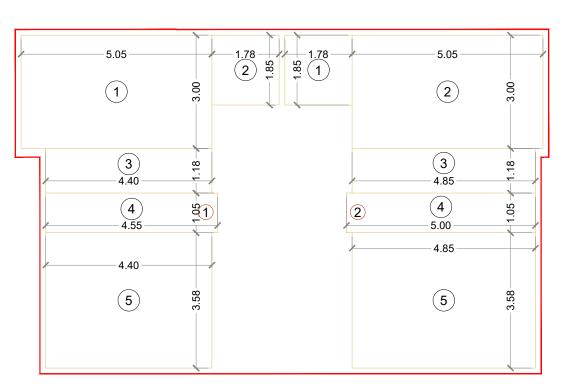


AREA LINE DIAG. 7TH FLOOR (FLAT No. 2)

SCALE 1:100

RERA CARPET AREA CALCULATION

7TH FLOOR (FLAT No. 2)								1 NOS
1	1.78	Χ	1.85	Χ	1 NO	=	3.29	SQ.MT.
2	5.05	Х	3.00	Χ	1 NO	=	15.15	SQ.MT.
3	4.85	Χ	1.18	Χ	1 NO	=	5.72	SQ.MT.
4	5.00	Х	1.05	Χ	1 NO	=	5.25	SQ.MT.
5	4.85	Χ	3.58	Χ	1 NO	=	17.36	SQ.MT.
TOTAL ADDITION							46.77	SQ.MT.

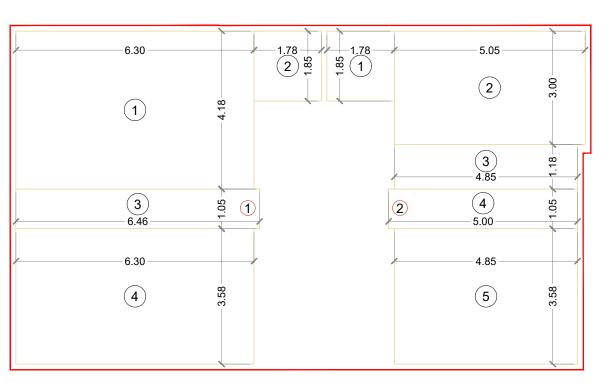

AREA LINE DIAG. 8TH & 10TH FLOOR (FLAT No. 1 & 2)


SCALE 1:100

RERA CARPET AREA CALCULATION

8TH & 10	TH FLOOF	R (FLA	AT No.	1)				3 NOS
1	6.30	Χ	4.18	Χ	1 NO	=	26.33	SQ.MT.
2	1.78	Χ	1.85	Χ	1 NO	=	3.29	SQ.MT.
3	6.46	Х	1.05	Χ	1 NO	=	6.78	SQ.MT.
4	6.30	Х	3.58	Χ	1 NO	=	22.55	SQ.MT.
			TC	OTAL	ADDITION	=	58.95	SQ.MT.

RERA CARPET AREA CALCULATION

8TH & 1	0TH FLOOR	R (FL	AT No.	2)				3 NOS
1	1.78	Х	1.85	Χ	1 NO	=	3.29	SQ.MT.
2	5.05	Х	3.00	Χ	1 NO	=	15.15	SQ.MT.
3	4.85	Х	1.18	Χ	1 NO	=	5.72	SQ.MT.
4	5.00	Х	1.05	Χ	1 NO	=	5.25	SQ.MT.
5	4.85	Х	3.58	Χ	1 NO	=	17.36	SQ.MT.
		=	46.77	SQ.MT.				

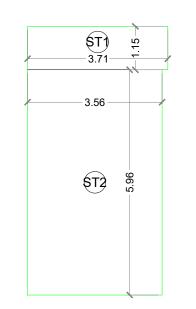

1ST FLOOR STAIRCASE, LIFT LOBBY AREA DIA.

STAIRCASE & LIFT LOBBY AREA CALCULATION

1ST FLOC)R					
ST1	3.71	Χ	1.15 X	1 NO	=	4.27 SQ.MT
ST2	3.56	Х	5.96 X	1 NO	=	21.22 SQ.MT
		=	25.49 SQ.MT			

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ACCEPTED AS COMPLETION PLANS AS ACCOMPANIMENT OF ACCEPTANCE OF O.C.C./ B.C.C. BY THIS OFFICE LETTER UNDER EVEN NO. P-10432/2022/(2519)/R/C WARD/EKSAR (RC)

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PLANS FOR APPROVAL

E.E.(B.P.) W.S II 'R-II'

S.E.(B.P.) R/C WARD	A.E.(B.P.) R-II WARD

KRISHNA H. MAKHELA (LICENSED SURVEYOR) LICENCE NO: M / 440 /LS

OWNER / DEVELOPER

FORM 'II"

CONTENTS OF SHEET

RERA CARPET AREA DIAGRAM & CALCULATION WITH STAIRCASE AREA DIAG. & CALCULATION.

DESCRIPTION OF PROP./ PROPERTY

PROPOSED REDEVELOPMENT OF EXISTING BUILDING KNOWN AS "BORIVALI DAULATNAGAR KIRTI CHSL" ON PLOT BEARING CTS NO. 2519 OF VILLAGE EKSAR OF DAULAT NAGAR BORIVALI (EAST), MUMBAI

NAME & ADDRESS OF OWNER

SHRI. SAHIL M. VIRANI

400068.

201, TANISHKA COMMERCIAL PREMISES, AKURLI ROAD ,W,E. HIGHWAY, KANDIVALI (EAST) 4000101.

NAME ADDRESS OF R.C.C. CONSULTANT

SHRI. ABHIJIT VINOD PHATARPEKAR 1201, AA WING, NL ARYAVARTA NL COMPLEX, ANAND NAGAR, DAHISAR (EAST) MUMBAI -

NAME & ADDRESS OF LICENSED SURVEYOR

KEYARCH

339, 3RD FLOOR, V-MALL, THAKUR COMPLEX, ASHA NAGAR ROAD, KANDIVALI (EAST), MUMBAI - 400 101.



KRISHNA H. MAKHELA (LICENSED SURVEYOR) LICENCE NO: M / 440 /LS

M.C. FILE NO.	1 -10-32/2022/(2313)/11/0 WARD/EROAR (110)						
RG. NO.	JOB NO.	FILE NAME	DRG. BY				
05			SAGAR				

L.M.R.

THIS DRAWING SHALL BE READ IN CONJUNCTION

UNDER THE PROVISION OF REG. NO. 11(6) & FULL OCCUPATION CERTIFICATE UNDER THE PROVISION OF REG. NO. 11(7) OF D.C.P.R. 2034 ISSUED UNDER

ACCEPTED AS COMPLETION PLANS AS ACCOMPANIMENT

OF ACCEPTANCE OF O.C.C./ B.C.C. BY THIS OFFICE

WITH THE BUILDING COMPLITION CERTIFICATE

NO. P-10432/2022/(2519)/R/C WARD/EKSAR (RC)

NO. P-10432/2022/(2519)/R/C WARD/EKSAR (RC)

THIS DRAWING IS DIGITALLY SIGNED, HENCE NO

PLANS FOR APPROVAL

E.E.(B.P.) W.S II 'R-II'

FORM 'II"

PROPOSED REDEVELOPMENT OF EXISTING BUILDING KNOWN

AS "BORIVALI DAULATNAGAR KIRTI CHSL" ON PLOT BEARING CTS NO. 2519 OF VILLAGE EKSAR OF DAULAT NAGAR BORIVALI

A.E.(B.P.) R-II WARD

OWNER / DEVELOPER

PHYSICAL SIGNATURE IS REQUIRED.

SIGNED ON EVEN DATE

LETTER UNDER EVEN

S.E.(B.P.) R2

KRISHNA H. MAKHELA (LICENSED SURVEYOR)

LICENCE NO: M / 440 /LŚ

DESCRIPTION OF PROP./ PROPERTY

201, TANISHKA COMMERCIAL PREMISES,

NAME ADDRESS OF R.C.C. CONSULTANT

SHRI. ABHIJIT VINOD PHATARPEKAR

AKURLI ROAD ,W,E. HIGHWAY, KANDIVALI

1201, AA WING, NL ARYAVARTA NL COMPLEX,

ANAND NAGAR, DAHISAR (EAST) MUMBAI -

NAME & ADDRESS OF LICENSED SURVEYOR

NAME & ADDRESS OF OWNER

SHRI. SAHIL M. VIRANI


CONTENTS OF SHEET

SECTION A-A, B-B

(EAST), MUMBAI


(EAST) 4000101.



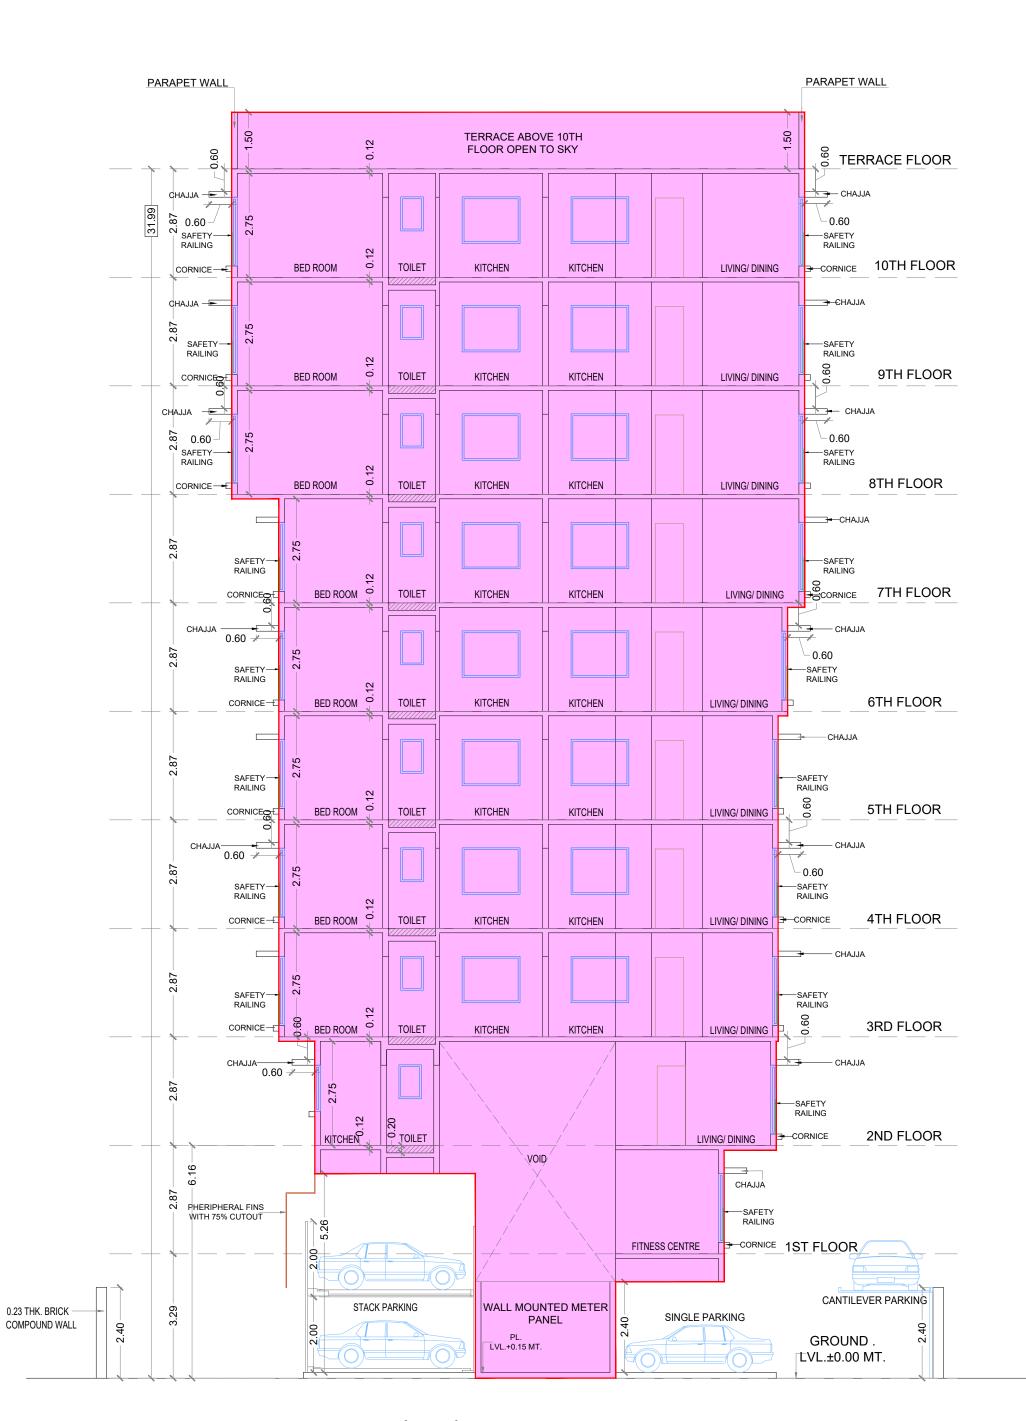

SECTION- A'A'

SCALE = 1 : 100

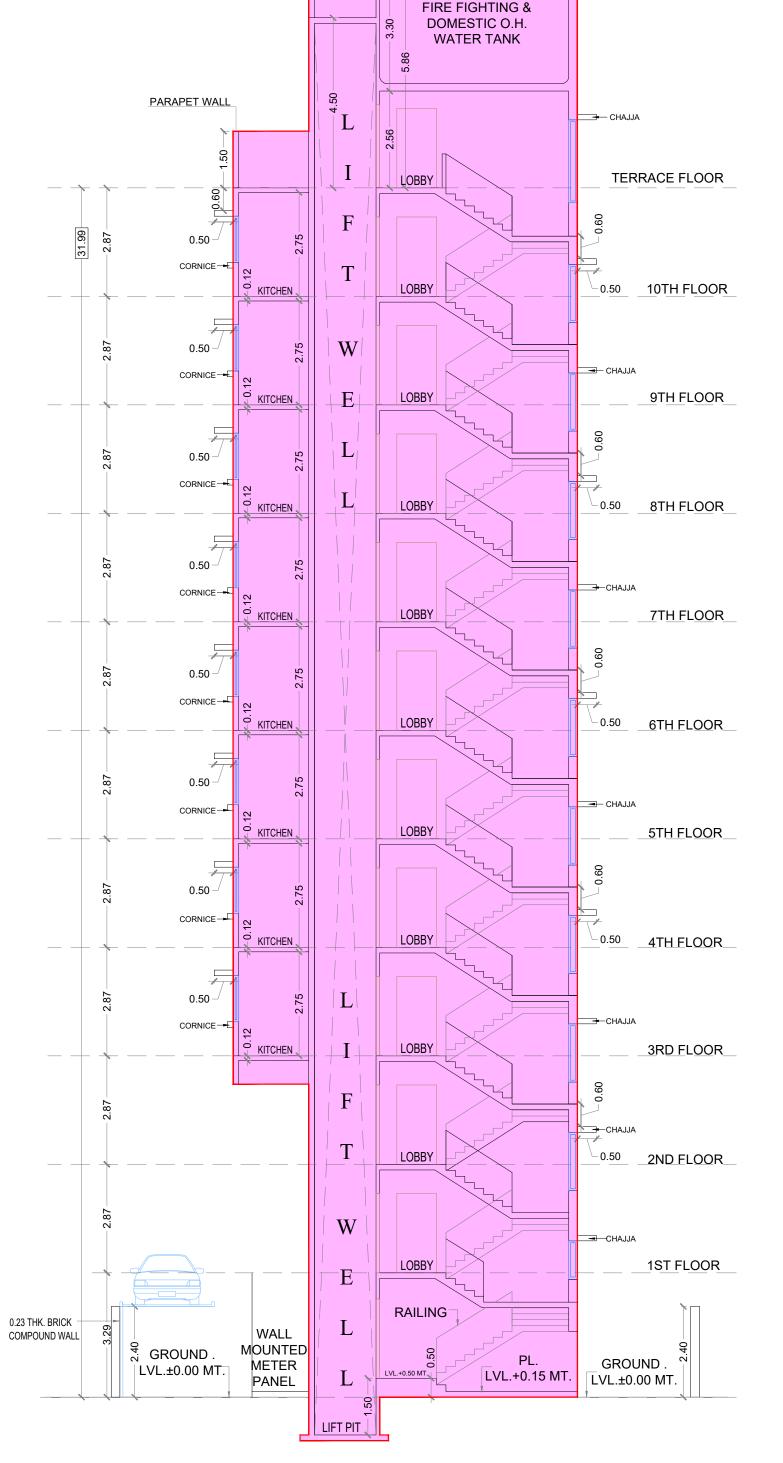

KEYARCH 339, 3RD FLOOR, V-MALL,

THAKUR COMPLEX, ASHA NAGAR ROAD, KANDIVALI (EAST), MUMBAI - 400 101. (LICENSED SURVEYOR) LICENCE NO: M / 440 /LS

B.M.C. FILE NO. P-10432/2022/(2519)/R/C WARD/EKSAR (RC) DRG. NO. FILE NAME DRG. BY SAGAR

SECTION-B'B'

SCALE = 1:100